SITE PLANS PREPARED FOR

CONGREGATION KNESSES ISRAEL

VILLAGE OF NEW HEMPSTEAD ROCKLAND COUNTY, NEW YORK

APPLICANT - OWNER CONGREGATION KNESSES ISRAEL 698 UNION RD NEW HEMPSTEAD, NEW YORK, 10977

SITE ENGINEER WEINBERGLIM ENGINEERING DPC 7 PATRICIA LANE SPRING VALLEY, NEW YORK 10977 (845) 570-0401

LAND SURVEYOR COLLIERS ENGINEERING & DESIGN 400 COLUMBUS AVENUE VALHALLA, NEW YORK 10595 (877) 627-3772



VICINITY MAP


		LISTOF DRAWINGS		
<u> </u>	NO.	DESCRIPTION	ORIGINAL DATE	LAST REVISION
				DATE
	1	TITLESHEET	9/12/2024	
	2	LAYOUTPLAN	3/20/2024	5/29/2024
	3	GRADING, DRAINAGE & UTILITY PLAN	6/28/2024	6/28/2024
	4	LANDSCAPE & LIGHTING PLAN	10/28/2024	11/12/2024
	5	DEMOLITION PLAN	5/24/2024	
	6	SEDIMENT & EROSION CONTROL PLAN	6/28/2024	11/12/2024
	7	CONSTRUCTION DETAILS	6/28/2024	
	8	INFORMATION DRAWINGS	6/29/2024	

Dig Safely. New York 800-962-7962 www.digsafelynewyork.org

- ☐ Call Before You Dig
- ☐ Confirm Utility Response

☐ Wait The Required Time ☐ Respect the Marks □ Dig With Care

THIS SITE PLAN SET IS FOR LOT B ONLY. ALL INFORMATION SHOWN FOR LOT A IS FOR INFORMATIONAL PURPOSES ONLY.

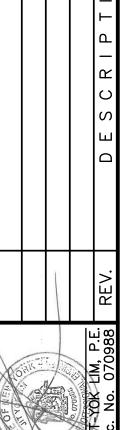



ISRAEL


CONGREGATION

Job number: 23005

Drawn by:


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Drawing Number

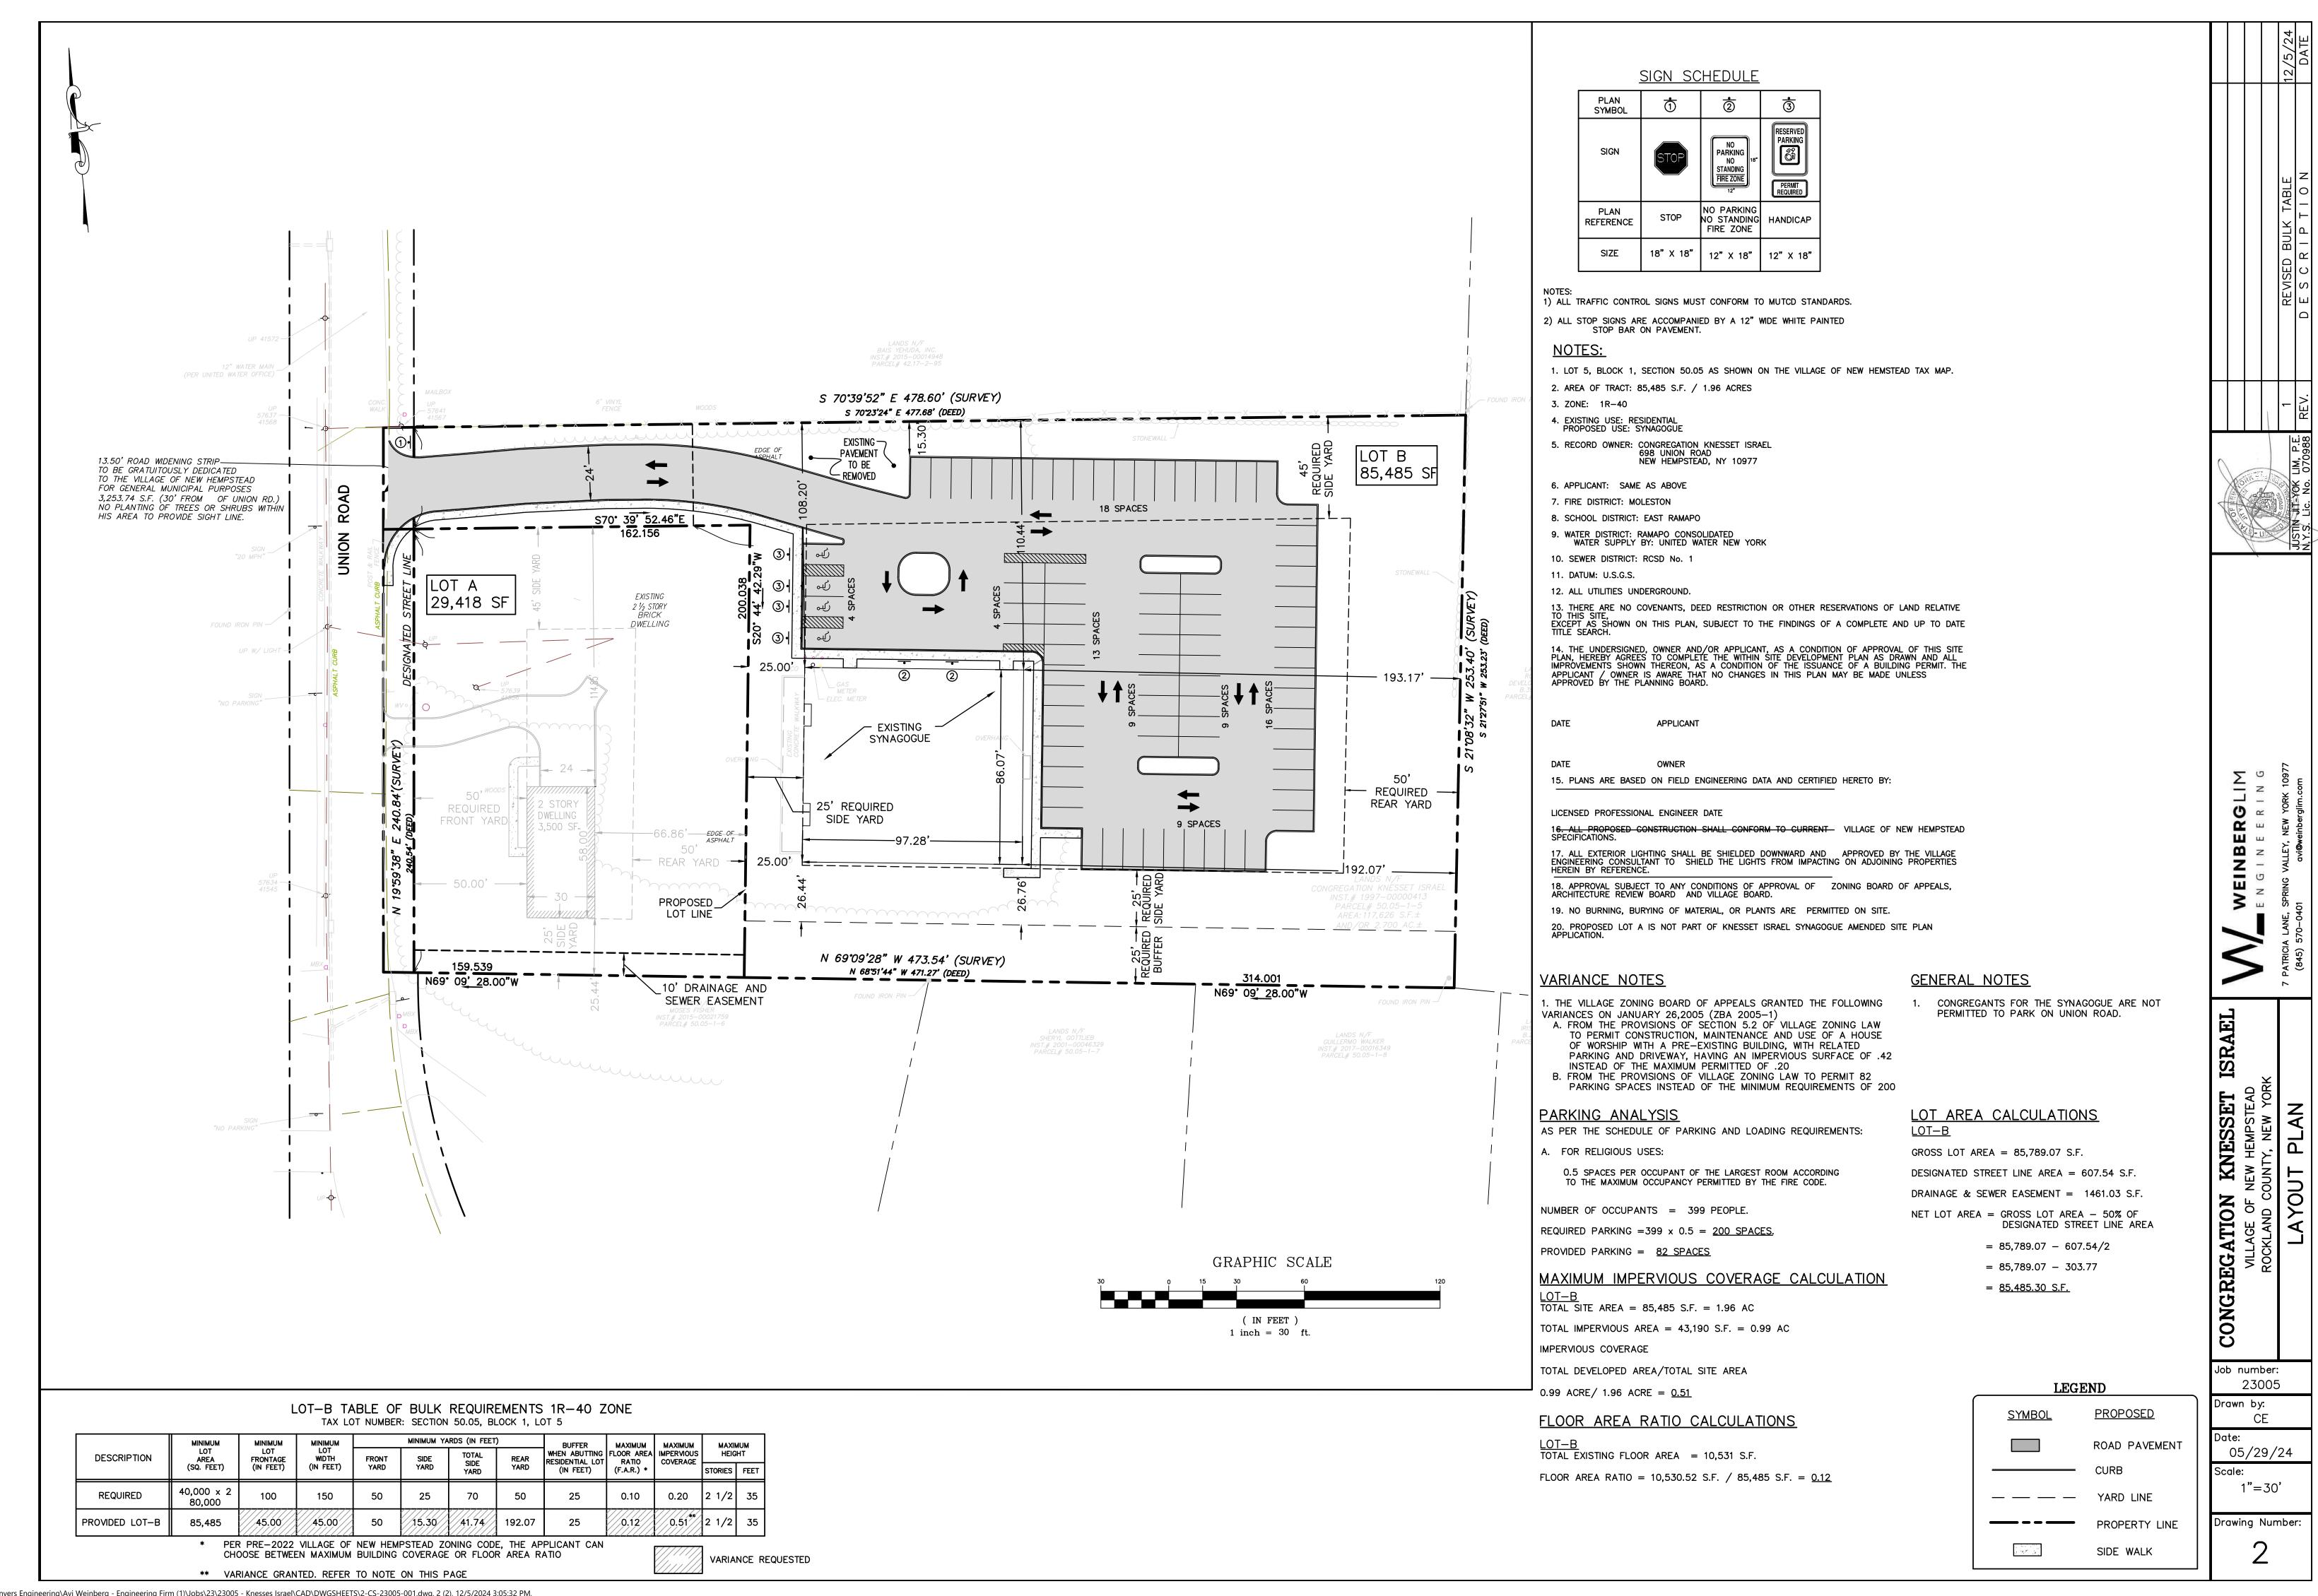


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ARCH full bleed D (24.00 x 36.00 Inches)




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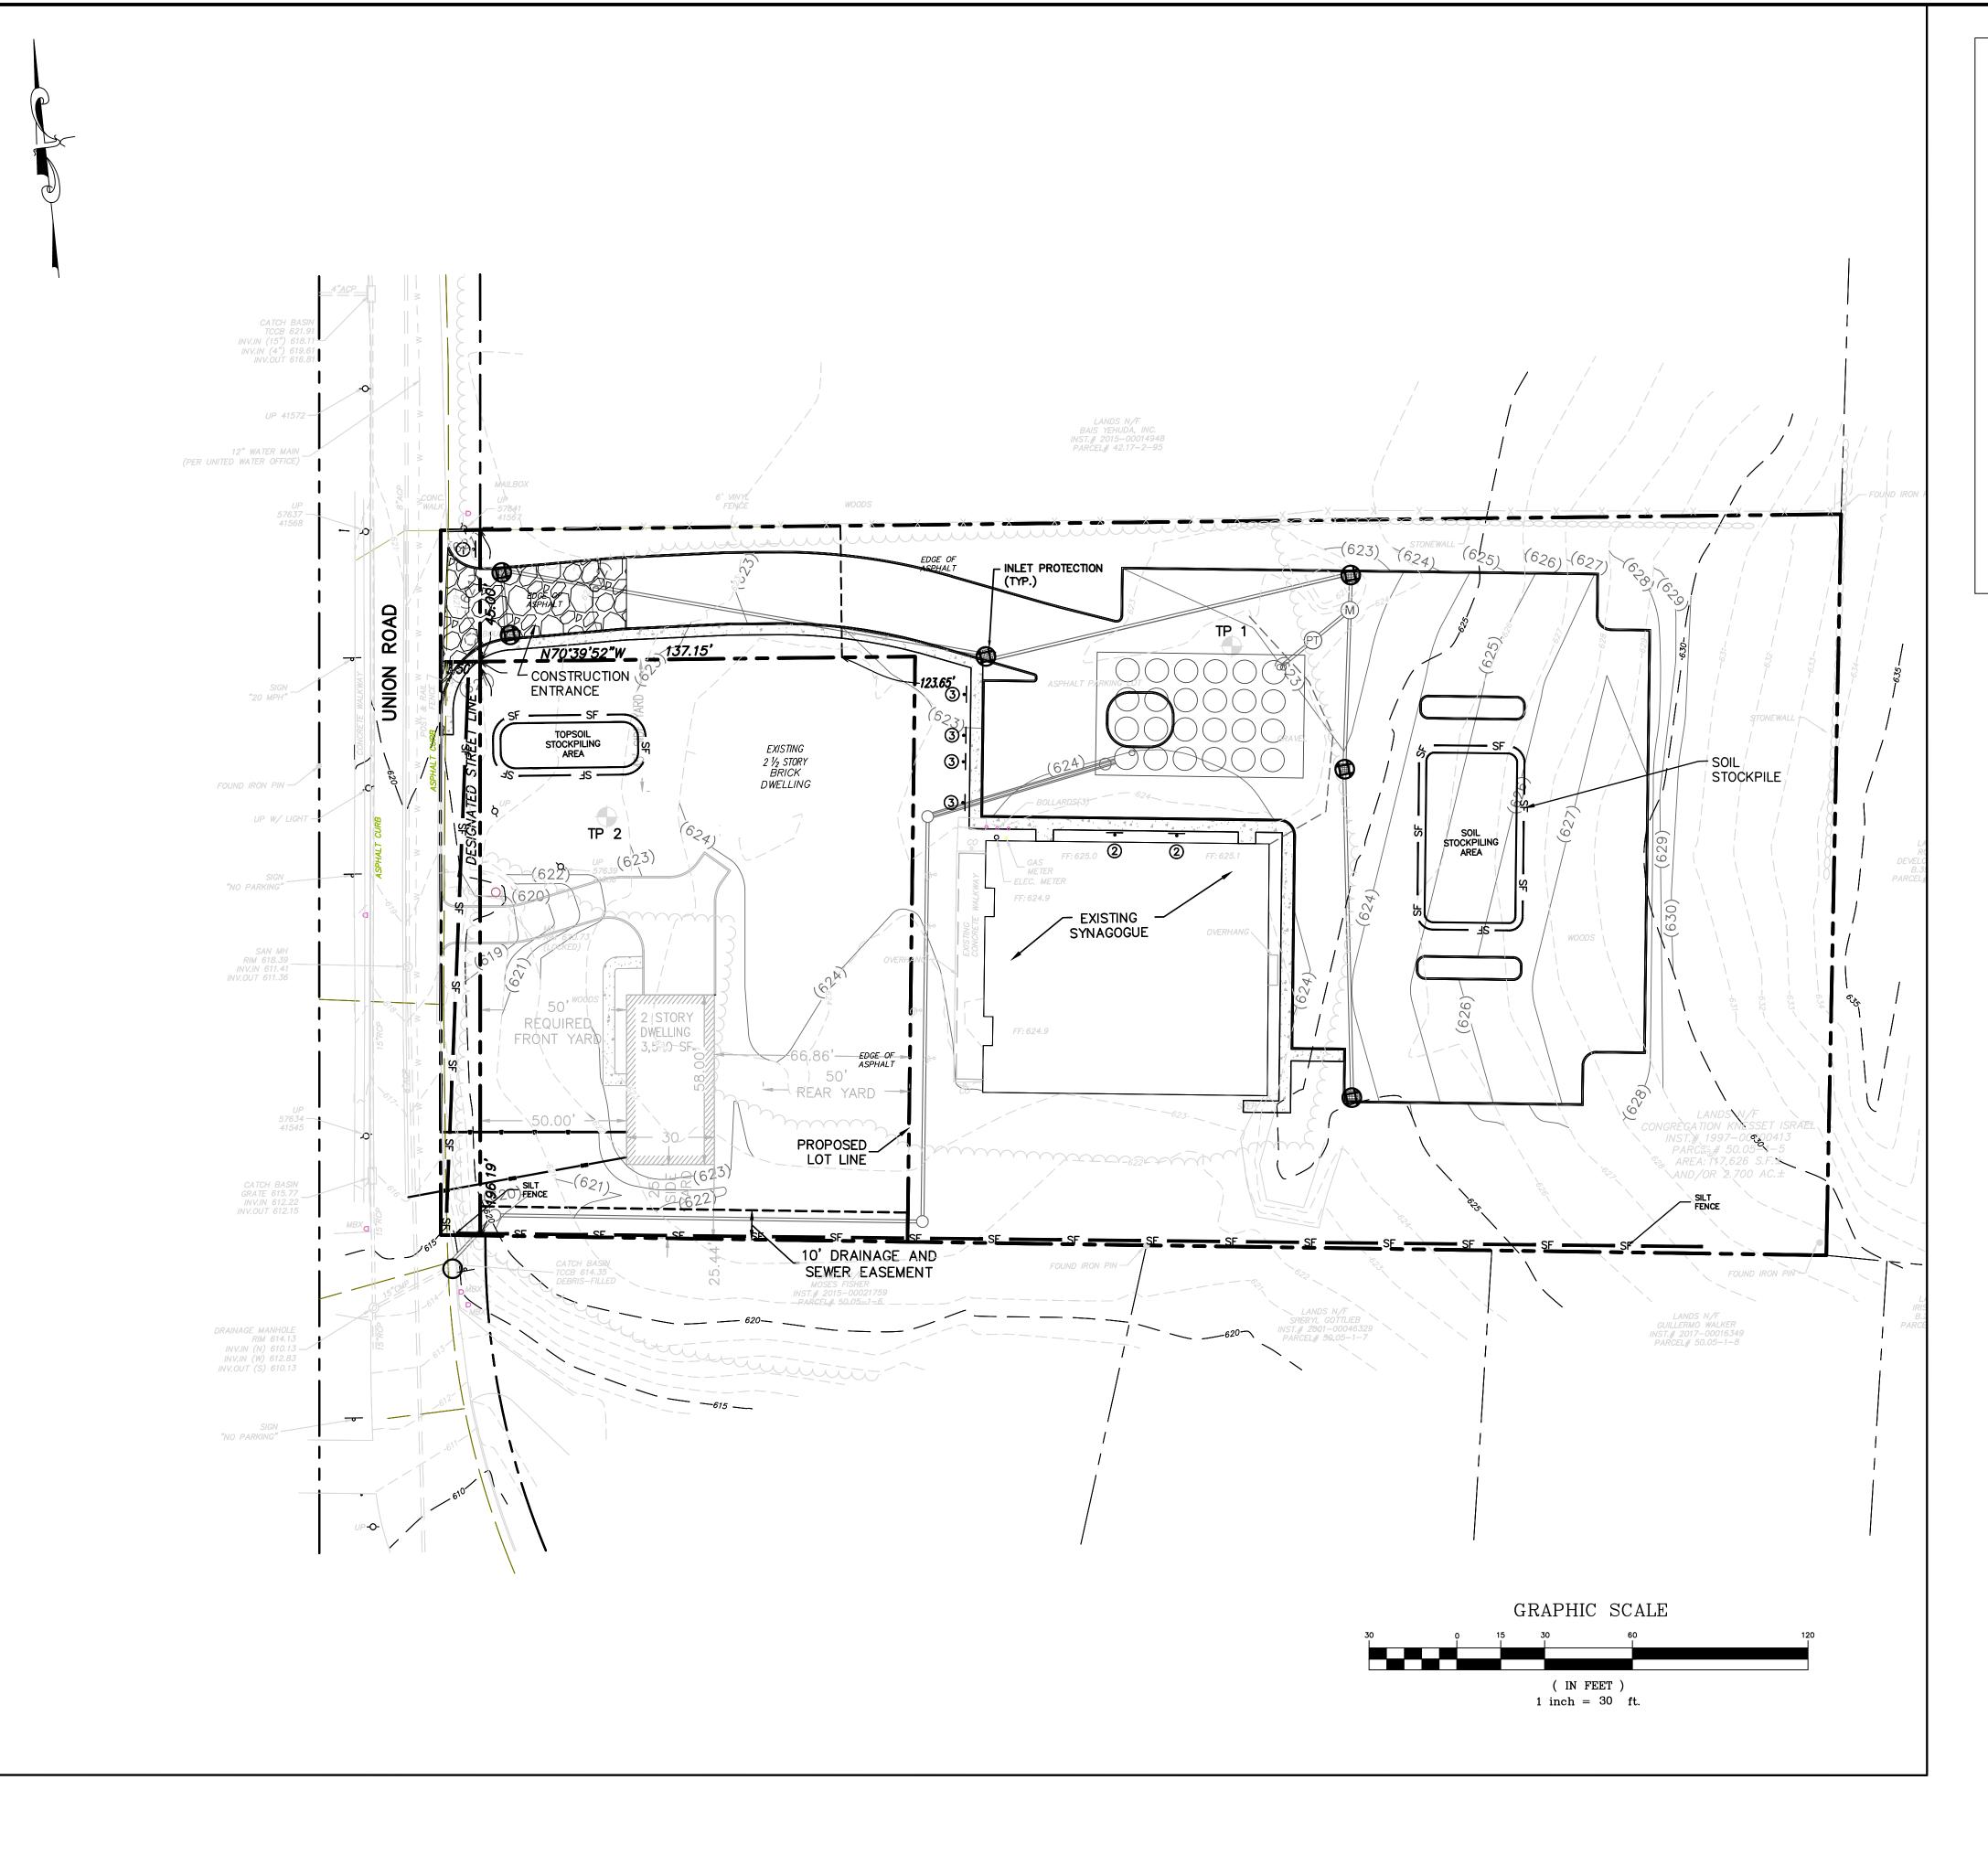
ARCH full bleed D (24.00 x 36.00 Inches)

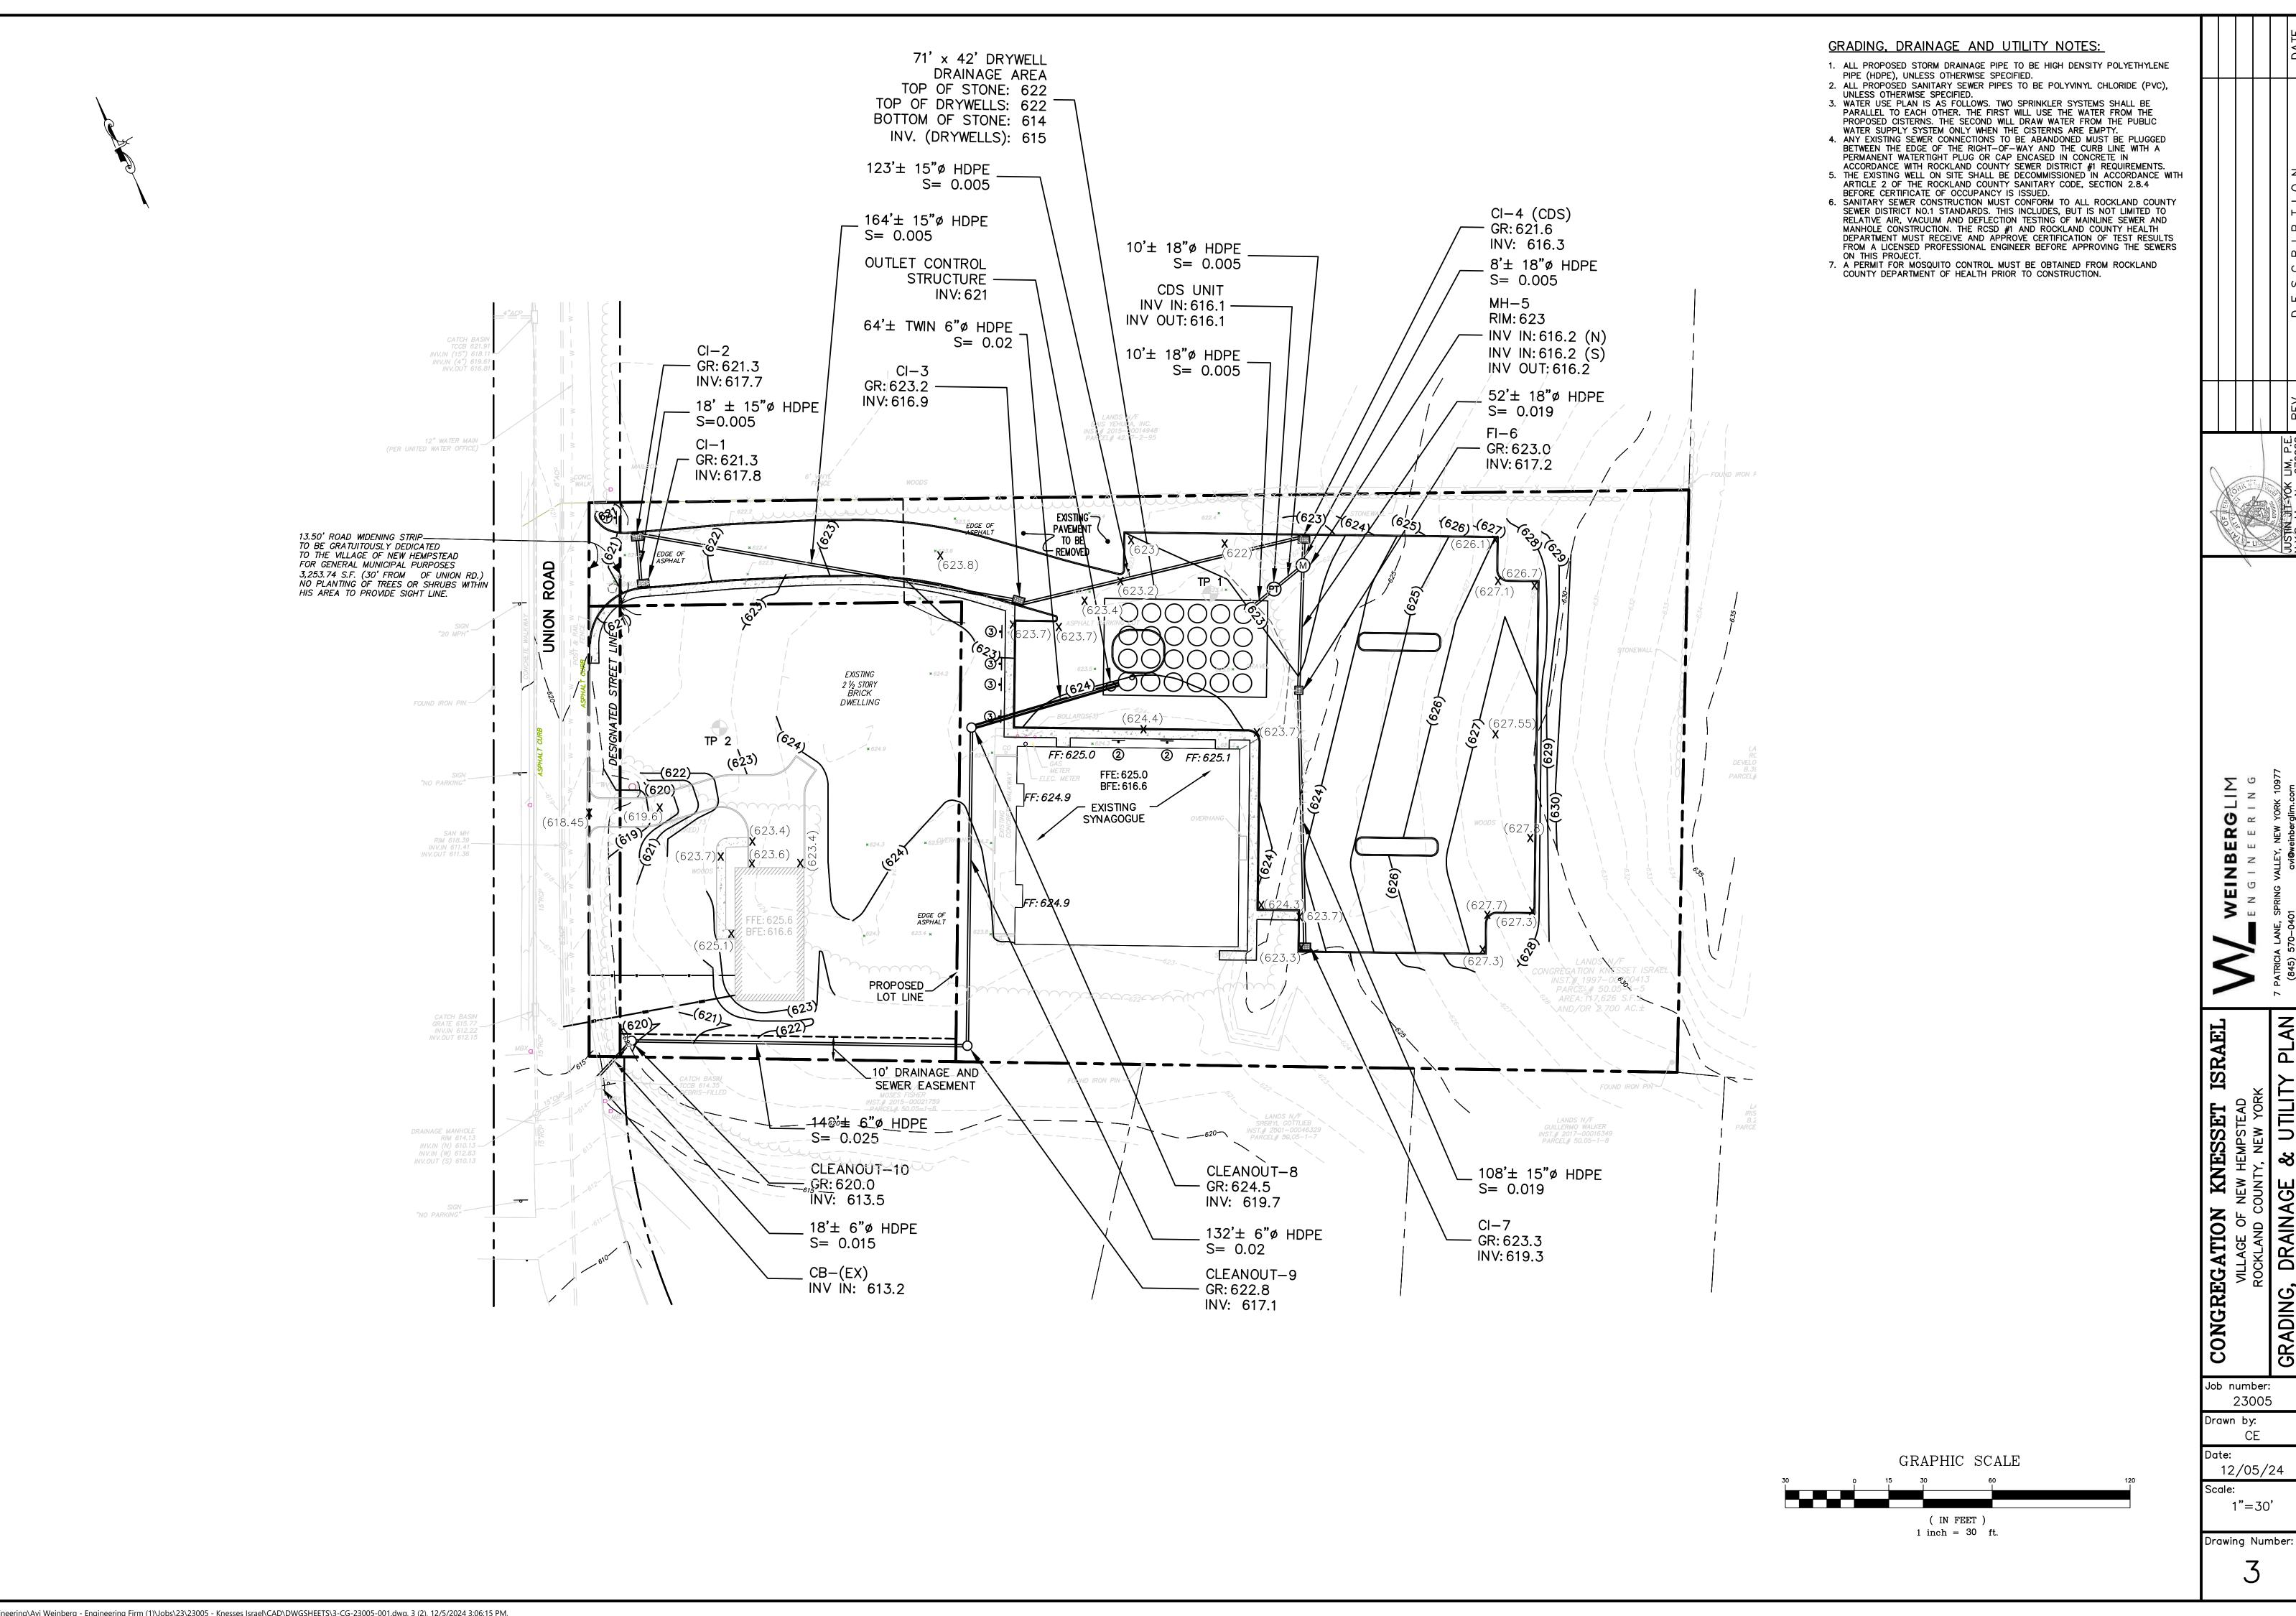

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STANDARD EROSION CONTROL NOTES

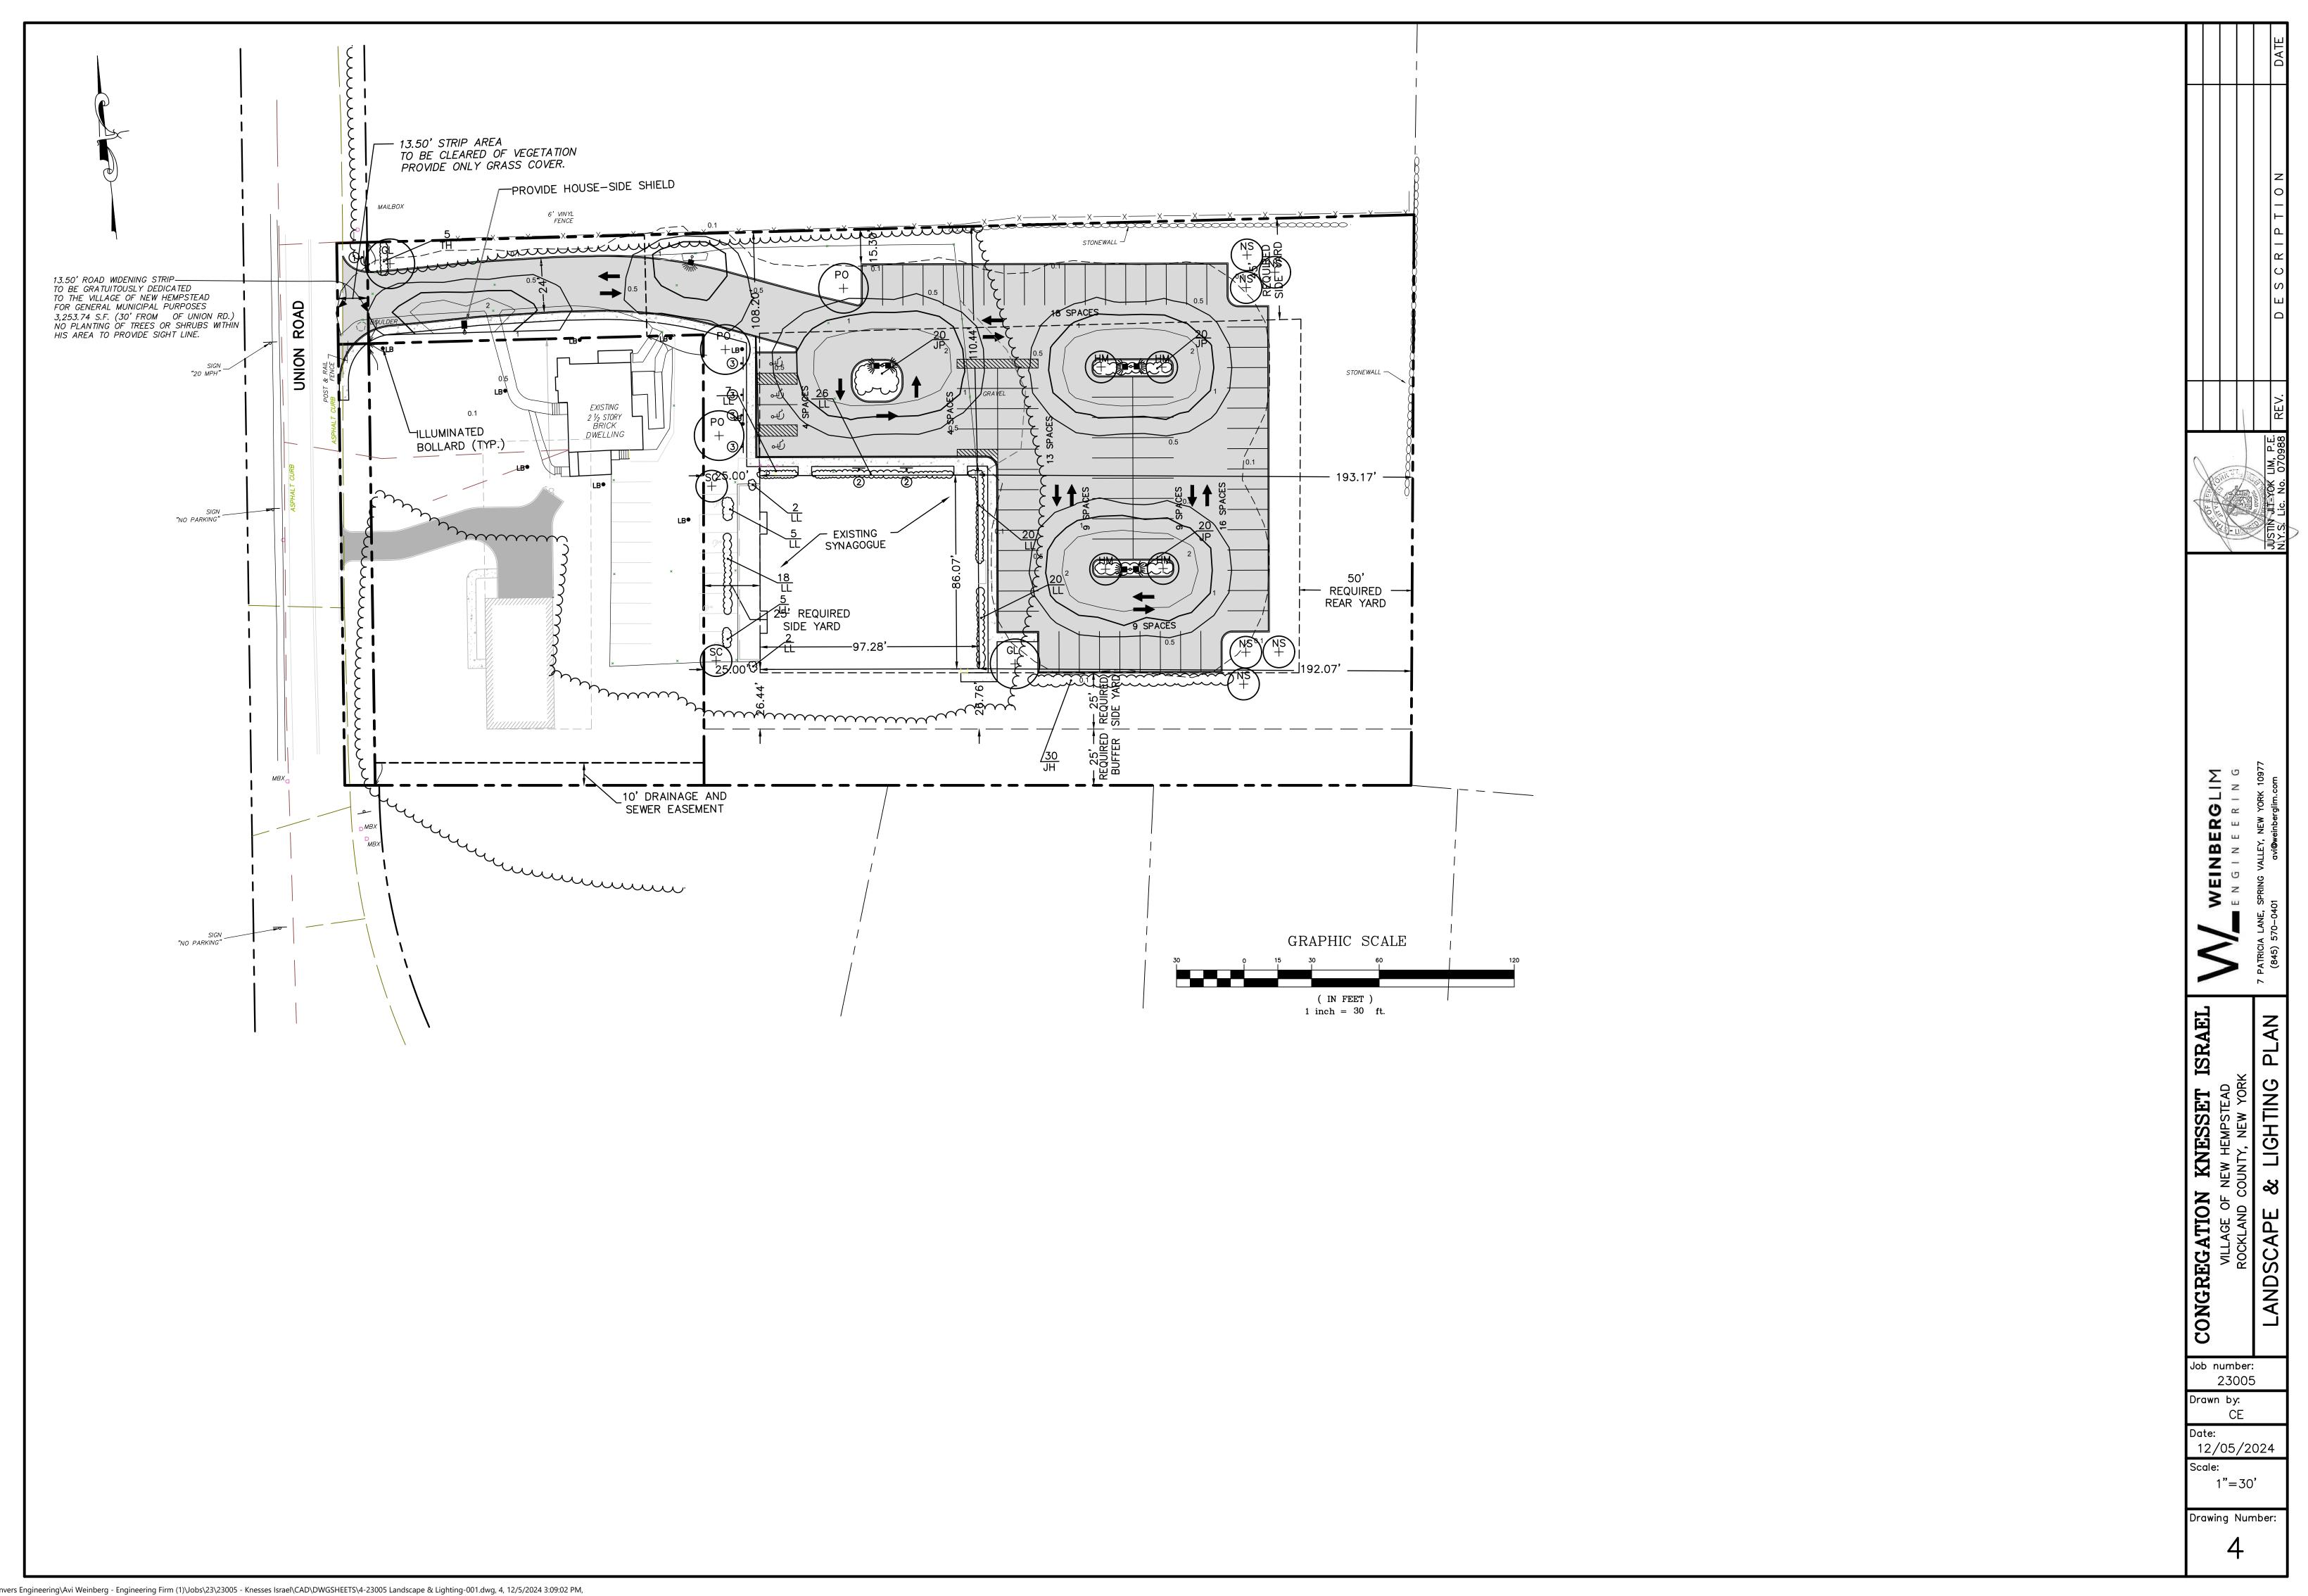AN EROSION CONTROL SYSTEM WILL BE UTILIZED BY THE DEVELOPER TO MINIMIZE THE PRODUCTION OF SEDIMENT FROM THE SITE. METHODS TO BE UTILIZED WILL BE THOSE FOUND MOST EFFECTIVE FOR THE SITE AND SHALL INCLUDE, BUT ARE NOT LIMITED TO, ONE OR MORE OF THE FOLLOWING, AS APPLICABLE:

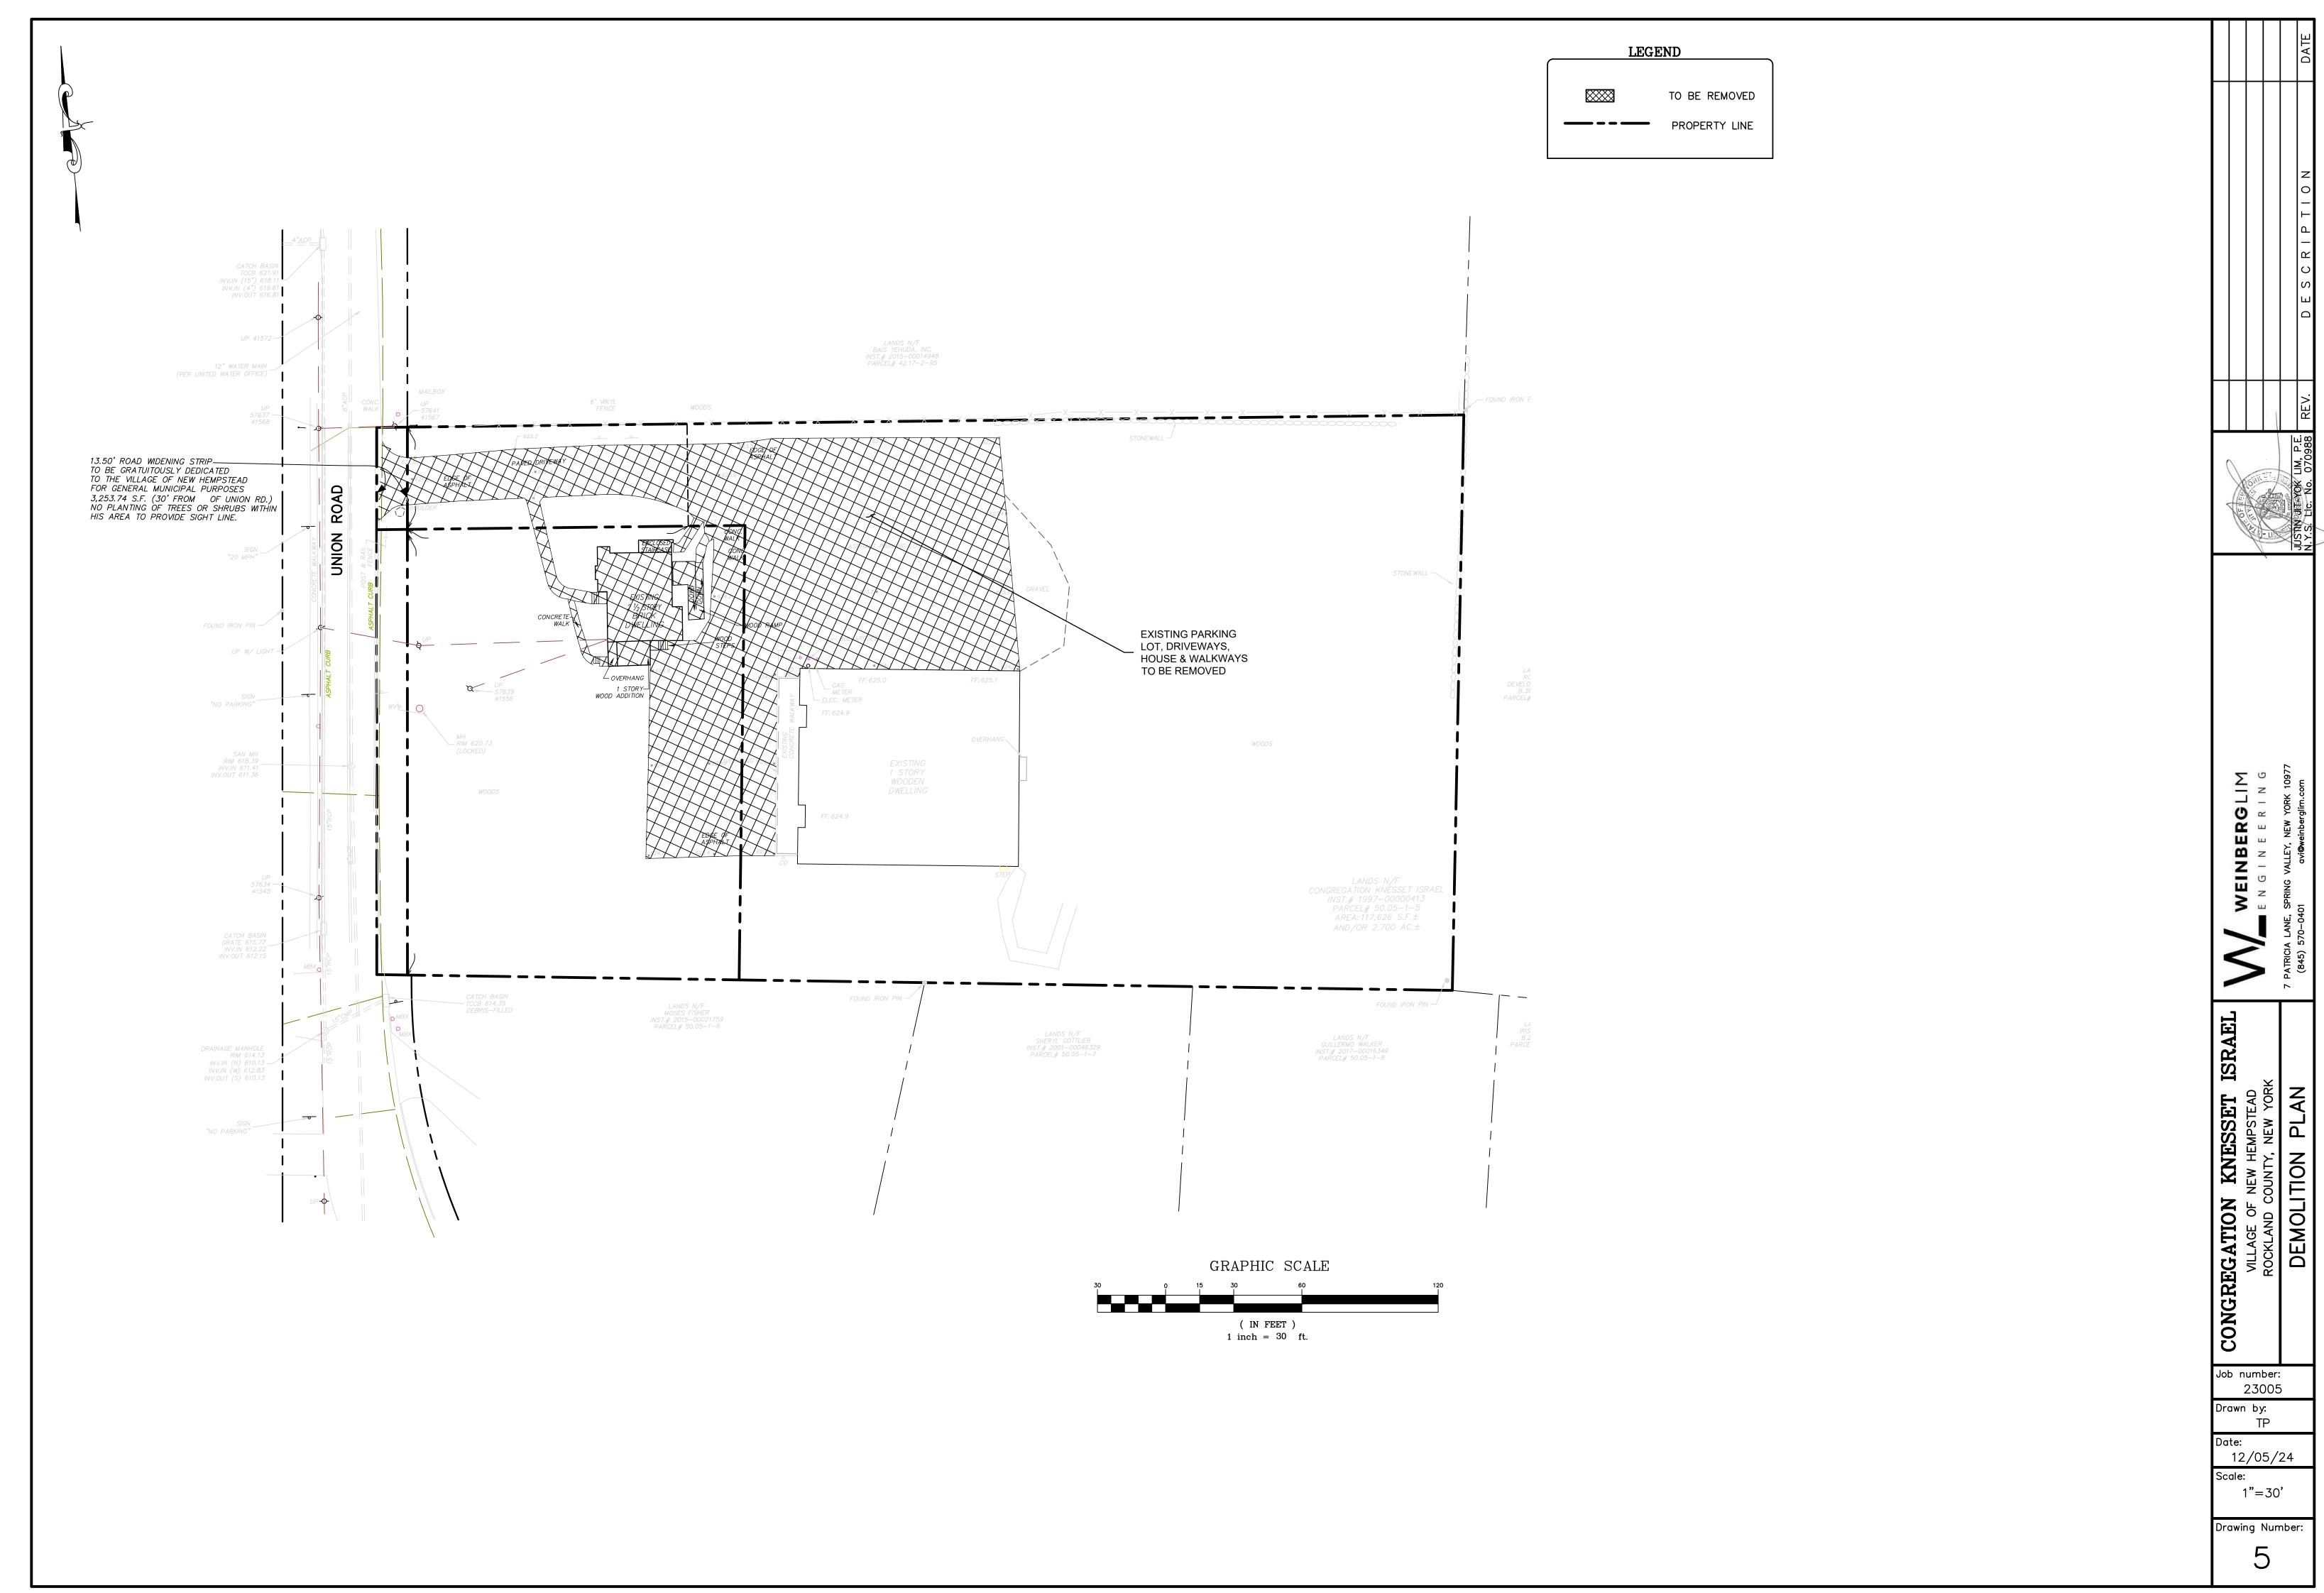- (1) THE PROPOSED LIMIT OF DISTURBANCE SHALL BE DEMARCATED IN THE FIELD WITH SNOW FENCE.
- (2) TEMPORARY SEDIMENT ENTRAPMENT AREAS SHALL BE PROVIDED AT KEY LOCATIONS TO INTERCEPT AND CLARIFY SILT LADEN RUNOFF FORM THE SITE. THESE MAY BE EXCAVATED OR MAY BE CREATED UTILIZING EARTHEN BERMS, RIP-RAP OR CRUSHED STONE DAMS, HAY BALES OR OTHER SUITABLE MATERIALS. DIVERSION SWALES, BERMS OR OTHER CHANNELIZATION SHALL BE CONSTRUCTED TO ENSURE THAT ALL SILT LADEN WATERS ARE DIRECTED INTO THE ENTRAPMENT AREAS, WHICH SHALL NOT BE PERMITTED TO FILL IN, BUT SHALL BE CLEANED PERIODICALLY DURING THE COURSE OF CONSTRUCTION. THE COLLECTED SILT SHALL

BE DEPOSITED IN AREAS SAFE FROM FURTHER EROSION. (3) ALL DISTURBED AREAS, EXCEPT ROADWAYS, WHICH WILL REMAIN UNDISTURBED FOR MORE THAN 14 DAYS SHALL BE TEMPORARILY SEEDED WITH 1/2 LB. OF RYE GRASS OR MULCHED WITH 100 LBS. OF STRAW OR HAY PER 1,000 SQ. FT. ROADWAYS SHALL BE STABILIZED AS RAPIDLY AS PRACTICAL BY THE INSTALLATION OF THE BASE COURSE, BUT TEMPORARY ASPHALT STABILIZATION MAY BE

- (4) SILT THAT LEAVES THE SITE IN SPITE OF THE REQUIRED PRECAUTIONS SHALL BE COLLECTED AND REMOVED.
- (5) DUST CONTROL: SHOULD DUST BECOME A NUISANCE DURING CONSTRUCTION OCCASIONAL SPRINKLING OF THE SITE MAY BE NECESSARY AND WILL BE PERFORMED AS REQUIRED.
- (6) EROSION IN THE VICINITY OF SOIL STOCKPILES SHALL BE PREVENTED BY INSTALLING SILT FENCE REINFORCED WITH HAY BALES AROUND THE PERIMETER OF THE PILE. TEMPORARY SEEDING SHALL BE APPLIED TO THE STOCKPILE(S) IF THE PILE IS TO REMAIN UNUSED AND UNDISTURBED FOR MORE THAN 14 DAYS.
- (7) ALL EROSION AND SEDIMENT CONTROL MEASURES AND DEVICES SHALL REMAIN IN PLACE AND SHALL BE MAINTAINED BY THE CONTRACTOR IN ACCORDANCE WITH TOWN AND NYSDEC REQUIREMENTS AND REGULATIONS UNTIL THE SITE HAS BEEN FULLY STABILIZED IN ACCORDANCE WITH NYSDEC REGULATIONS.


<u>LEGEND</u> INLET PROTECTION SILT FENCE & LIMIT OF DISTURBANCE

CONSTRUCTION ENTRANCE

CONGREGATION Job number: 23005 Drawn by: 12/5/24 Scale: 1"=30' Drawing Number:

0


FINB

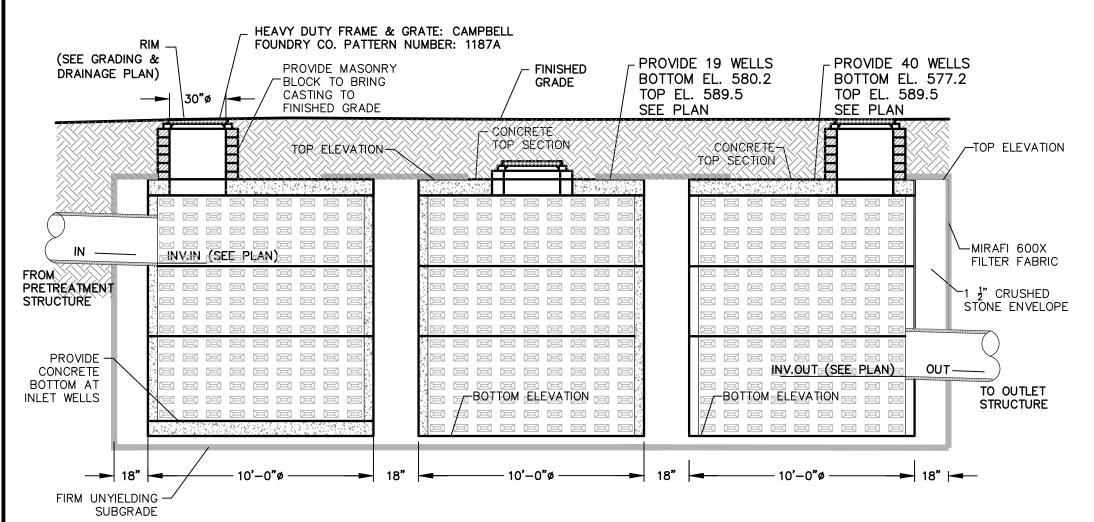

STORM DRAINAGE WQV-DETENTION SYSTEM DETAIL

N.T.S. 1. MINIMUM STRENGTH CONCRETE 4000 PSI

- 2. CONTRACTOR TO SUBMIT P.E. CERTIFIED SHOP DRAWINGS FOR APPROVAL BY THE ENGINEER PRIOR TO CONSTRUCTION.
- 3. STRUCTURE SHALL BE DESIGNED AND CERTIFIED TO WITHSTAND HS20 LOADING.
- 4. PROVIDE FRAMES AND COVERS AT WELLS AS INDICATED ON PLAN

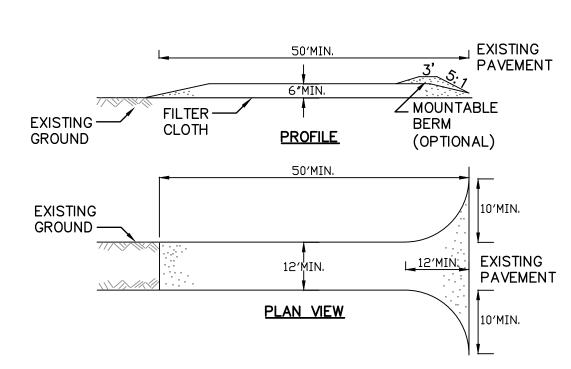


STABILIZED CONSTRUCTION ENTRANCE DETAIL

N.T.S.

CONSTRUCTION SPECIFICATIONS

- 1. STONE SIZE USE 2" STONE, OR RECLAIMED OR RECYCLED CONCRETE EQUIVALENT.
- 2. LENGTH NOT LESS THAN 50 FEET (EXCEPT ON A SINGLE RESIDENCE LOT WHERE A 30 FOOT MINIMUM LENGTH WOULD APPLY).
- 3. THICKNESS NOT LESS THAN SIX (6) INCHES.
- 4. WIDTH TWELVE (12) FOOT MINIMUM, BUT NOT LESS THAN THE FULL WIDTH AT POINTS WHERE
- INGRESS OR EGRESS OCCURS. TWENTY-FOUR (24) FOOT IF SINGLE ENTRANCE TO SITE. 5. FILTER CLOTH - WILL BE PLACED OVER THE ENTIRE AREA PRIOR TO PLACING OF STONE
- 6. SURFACE WATER ALL SURFACE WATER FLOWING OR DIVERTED TOWARD CONSTRUCTION ENTRANCES SHALL BE PIPED ACROSS THE ENTRANCE. IF PIPING IS IMPRACTICAL, A MOUNTABLE BERM WITH 5:1 SLOPES WILL BE PERMITTED.
- 7. MAINTENANCE THE ENTRANCE SHALL BE MAINTAINED IN A CONDITION WHICH WILL PREVENT TRACKING OR FLOWING OF SEDIMENT ONTO PUBLIC RIGHTS-OF-WAY, ALL SEDIMENT SPILLED, DROPPED, WASHED OR TRACTED ONTO PUBLIC RIGHTS-OF-WAY MUST BE REMOVED IMMEDIATELY.
- 8. WHEN WASHING IS REQUIRED, IT SHALL BE DONE ON A AREA STABILIZED WITH STONE AND WHICH DRAINS INTO AN APPROVED SEDIMENT TRAPPING DEVICE. 9. PERIODIC INSPECTION AND NEEDED MAINTENANCE SHALL BE PROVIDED AFTER EACH RAIN.

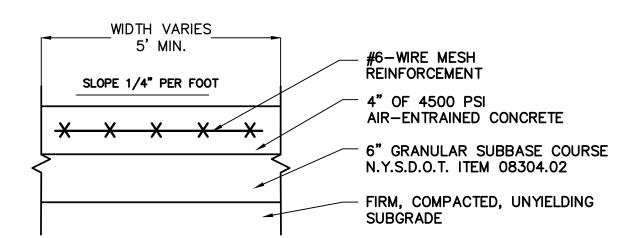

CONCRETE SIDEWALK DETAIL


PUBLIC WITHIN R.O.W.

N.T.S.

NOTES:

STRUCTURES.

- 1. PLACE CONTRACTION JOINTS EQUAL TO WALK WIDTH OR 6'-0" O.C.
- 2. BROOM FINISH EACH SQUARE AT 90' TO PRECEDING SQUARE. 3. INSTALL 1/2" PRE-MOLDED EXPANSION JOINT FILLER AT 24' O.C. MAX. AND AGAINST CONCRETE CURBS, BUILDINGS AND OTHER

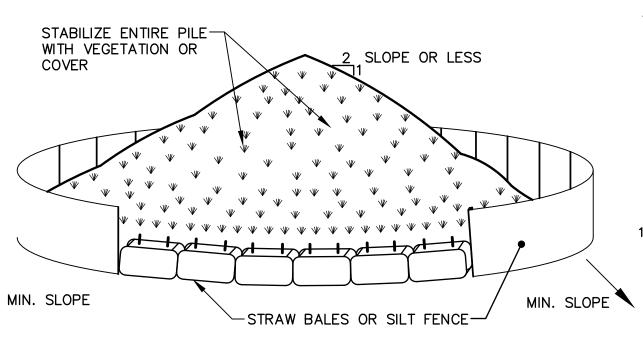


STOCKPILING

N.T.S.

INSTALLATION NOTES

1. AREA CHOSEN FOR STOCKPILING OPERATIONS SHALL BE DRY AND STABLE. 2. MAXIMUM SLOPE OF STOCKPILE SHALL BE 1:2. 3. UPON COMPLETION OF SOIL STOCKPILING, EACH PILE SHALL BE


SURROUNDED WITH EITHER SILT FENCING OR STRAW BALES, THEN STABILIZED WITH VEGETATION OR COVERED.

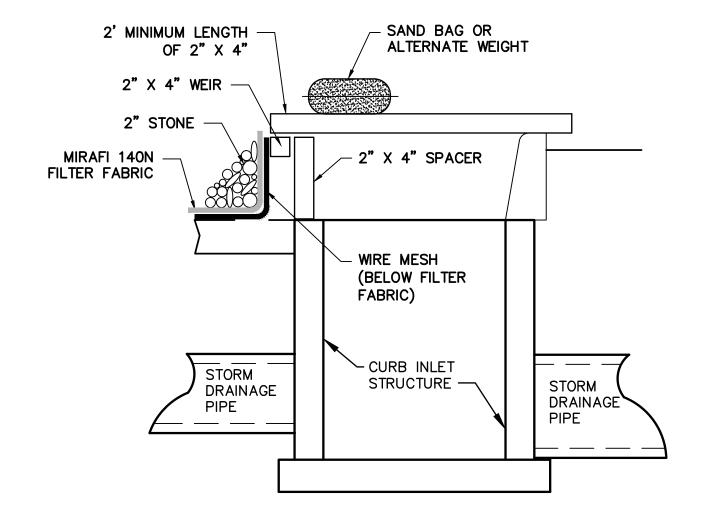

CURB INLET PROTECTION DETAIL


NOTES:

- 1. FILTER FABRIC SHALL HAVE AN EOS OF 40-85.
- 2. WOODEN FRAME SHALL BE CONSTRUCTED OF 2" X 4" CONSTRUCTION GRADE LUMBER.
- 3. WIRE MESH ACROSS THROAT SHALL BE A CONTINUOUS PIECE 30 INCH MINIMUM WIDTH WITH A LENGTH 4 FEET LONGER THAN THE THROAT. IT SHALL BE SHAPED AND SECURELY NAILED TO A 2" X 4" WEIR.
- 4. THE WEIR SHALL BE SECURELY NAILED TO 2" X 4" SPACERS 9 INCHES LONG SPACED NO MORE THAN 6 FEET APART.
- 5. THE ASSEMBLY SHALL BE PLACED AGAINST THE INLET AND SECURED BY 2" X 4" ANCHORS 2 FEET LONG EXTENDING ACROSS THE TOP OF THE INLET AND HELD IN PLACE BY SAND BAGS OR ALTERNATE WEIGHTS.

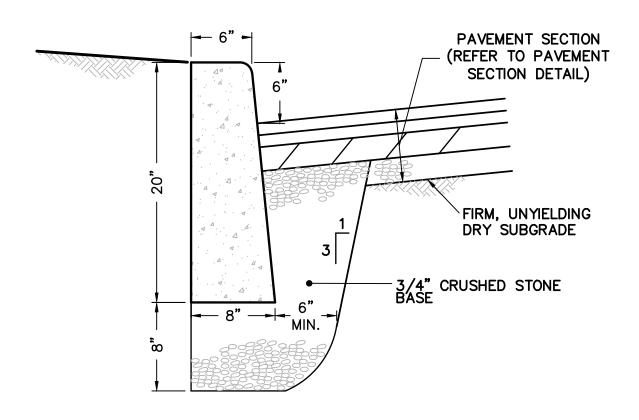


CURB DETAIL: CONCRETE N.T.S.

- 1. CURB SHALL BE CAST IN PLACE.
- 2. EXPANSION JOINTS OF 3/16" CELLULOSE OR SIMILAR MATERIAL SHALL BE PLACED AT TEN FOOT INTERVALS, TO FULL DEPTH OF CURB.
- 3. UNDERDRAIN MAY BE ELIMINATED IN PARKING LOTS AND OTHER NON-PUBLIC FACILITIES.

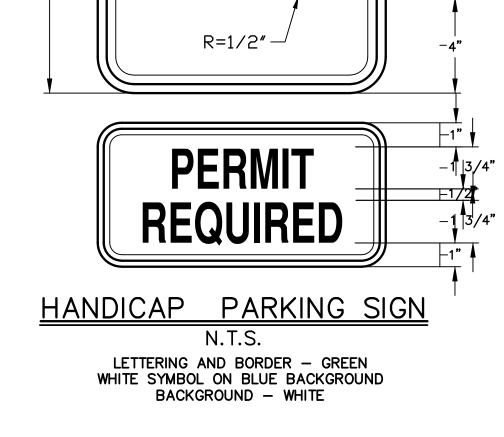


HEAVY DUTY FRAME & GRATE:

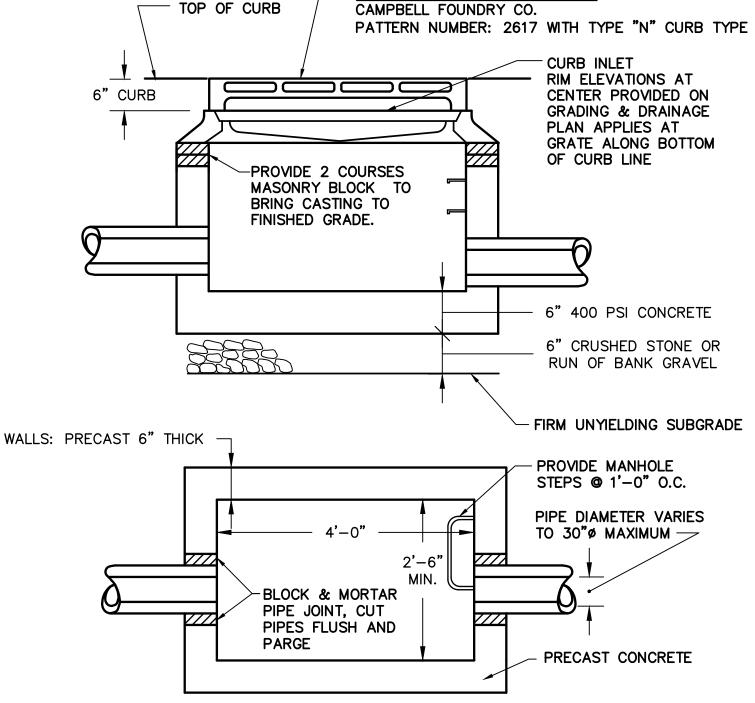


CATCH BASIN DETAIL CURB INLET (CI)

- 1. SLOPE CASTINGS TO MATCH SLOPE OF FINISHED
- PAVEMENT GRADE. 2. MINIMUM STRENGTH CONCRETE 4000 PSI WALL THICKNESS 4" WITH ADEQUATE STEEL REINFORCEMENT TO WITHSTAND H20 HIGHWAY LOAD AND SOIL LOADS.

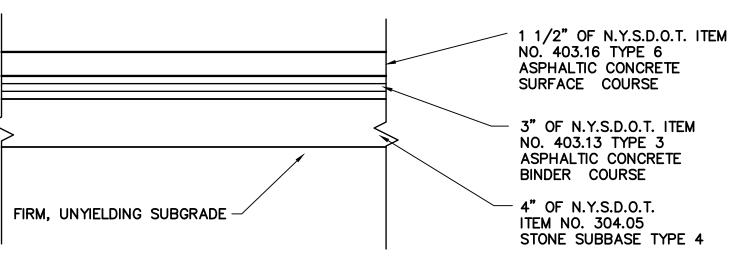

PAVEMENT SECTION: PUBLIC R.O.W.

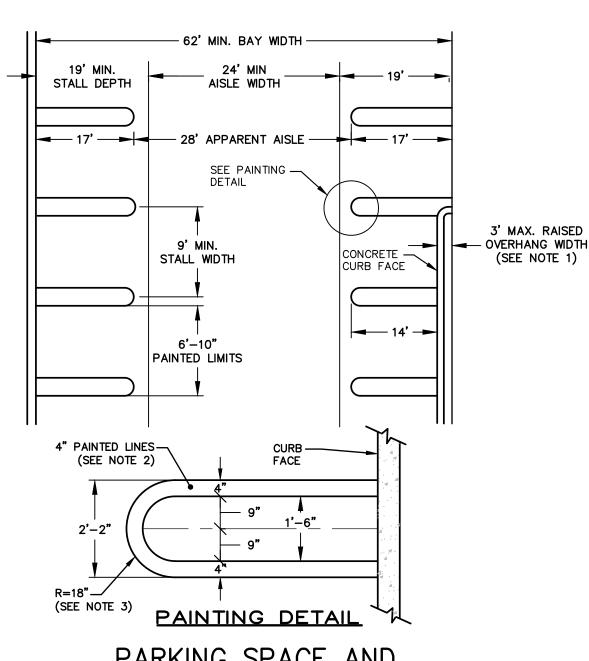


PARKING SPACE AND PAINTING SCHEDULE


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NOTE:

1) NOT MORE THAN THREE FEET OF NON-PAVED AREA ABUTTING A STALL MAY BE COUNTED AS STALL LENGTH PROVIDED A NON-MOUNTABLE CONCRETE CURB, NOT MORE THAN 6" ABOVE GRADE OF PARKING SURFACE IS PROVIDED. SUCH OVERHANG AREA SHALL NOT BE DEEMED TO MEET ANY WALK OR PLANTING REQUIREMENT. 2) PAINTED LINES TO BE NOT LESS THAN 4" IN WIDTH OF APPROVED EXTERIOR GRADE ROADWAY PAINT. 3) FLAT ENDS INSTEAD OF ROUNDED ENDS ARE PERMISSIBLE.

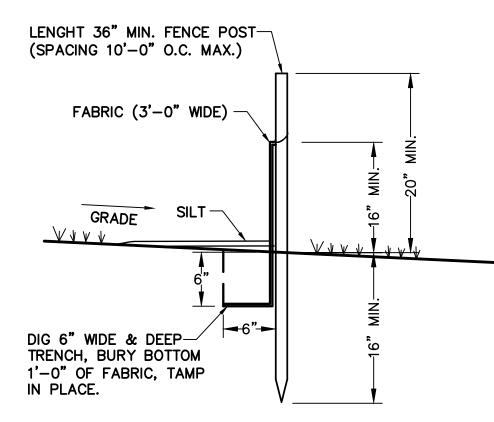

SILT FENCE DETAIL N.T.S.

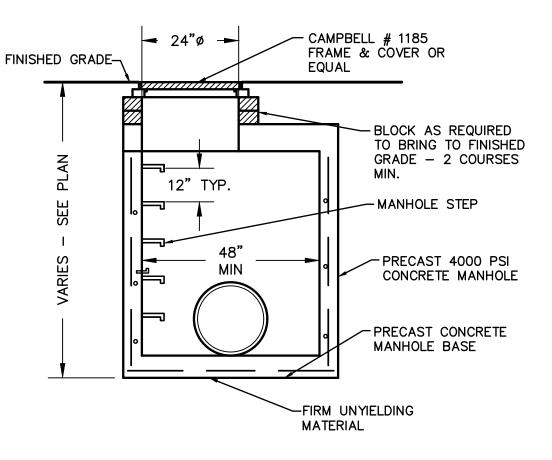

STORM MANHOLE DETAIL N.T.S.

1. MANHOLE TO CONFORM TO A.S.T.M. C478 (LATEST REVISION). 2. PRECAST CONCRETE MANHOLES WITH RESILENT SEALS AT

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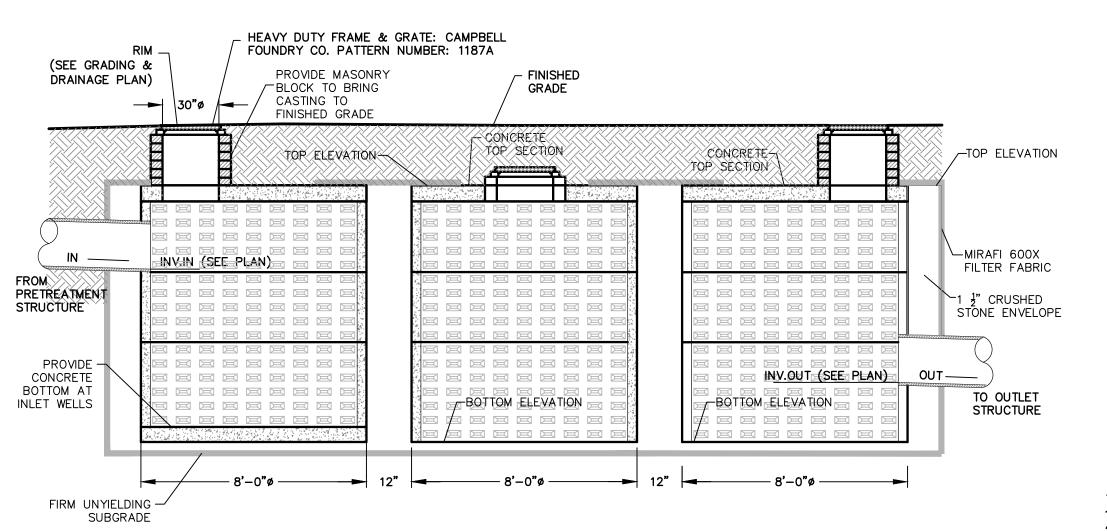
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CONGREGATION
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ROCKLAND CC

Job number: 23005 Drawn by: CE

Date: 06/28/24 Scale: 1"=30'

Drawing Number:




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STABILIZED CONSTRUCTION ENTRANCE DETAIL


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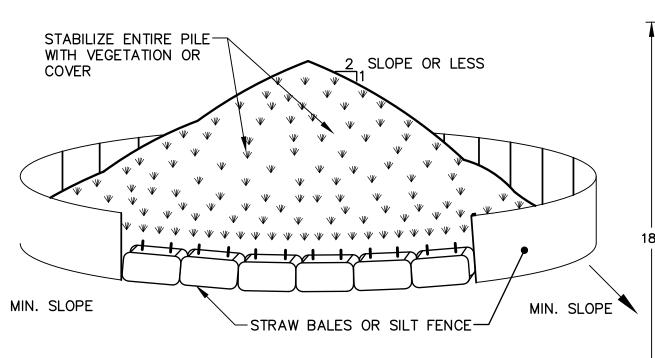
PUBLIC WITHIN R.O.W.

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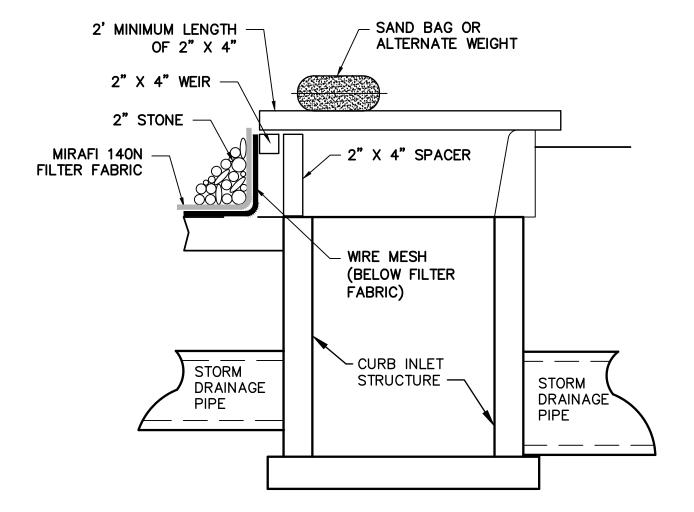
SOIL STOCKPILING

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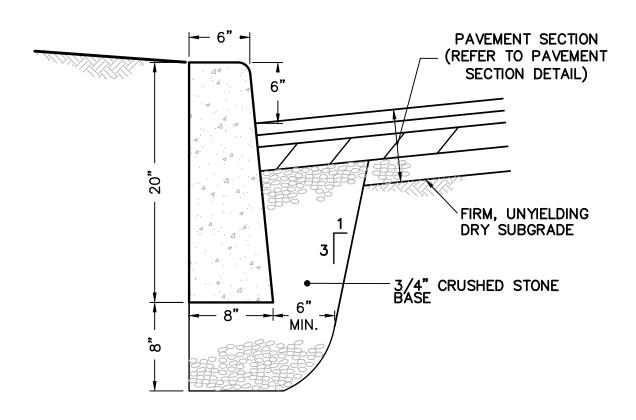
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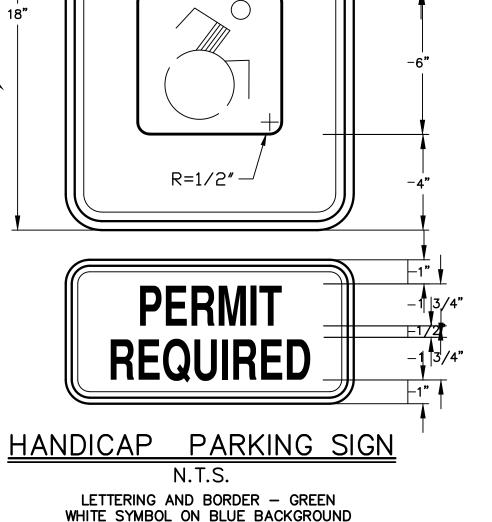
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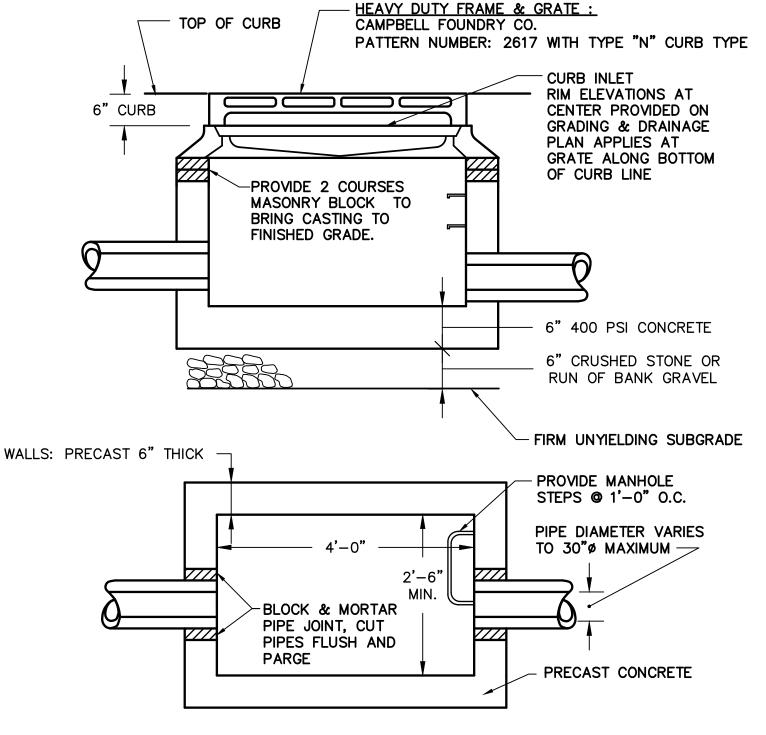
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LETTERING AND BORDER — GREEN WHITE SYMBOL ON BLUE BACKGROUND BACKGROUND — WHITE

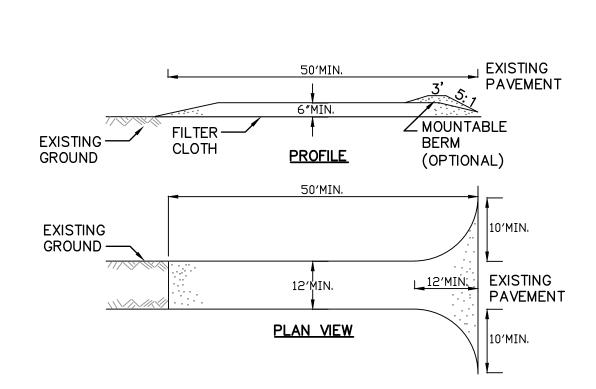


CATCH BASIN DETAIL CURB INLET (CI)

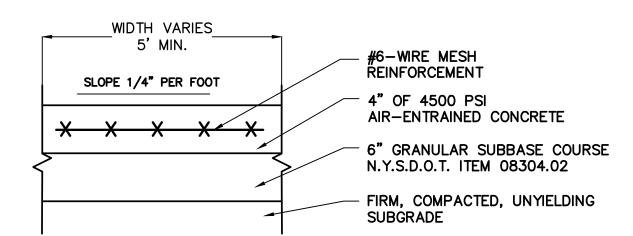
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PAVEMENT SECTION: PUBLIC R.O.W.




PAINTING SCHEDULE N.T.S.

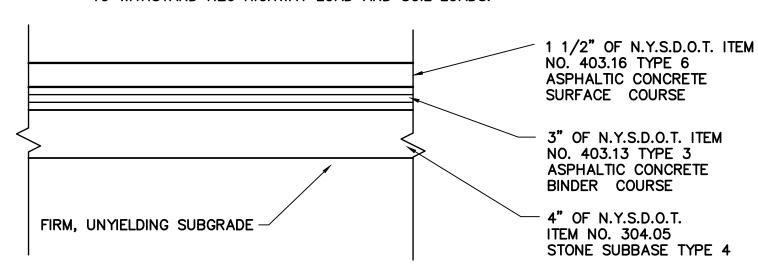NDTE:


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SILT FENCE DETAIL N.T.S.

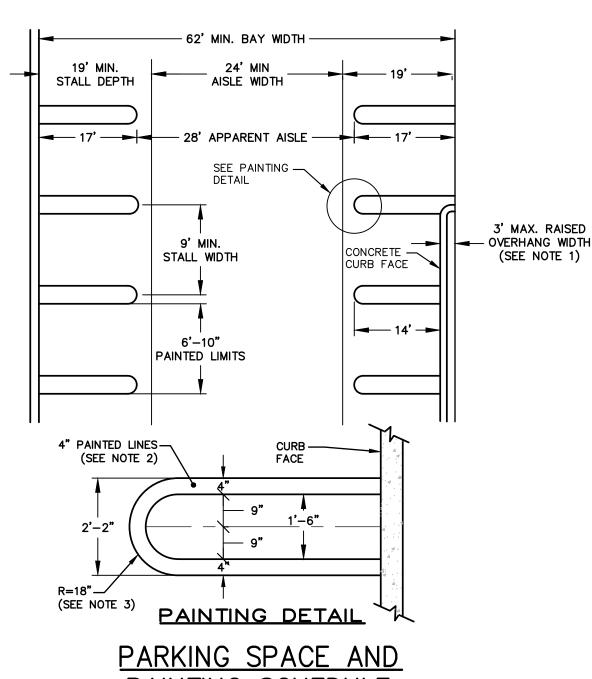

STORM MANHOLE DETAIL

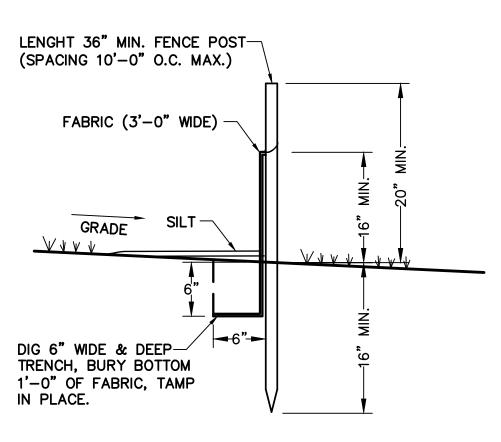N.T.S.

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JUSTIN JIT-YOK LIM, P.E.

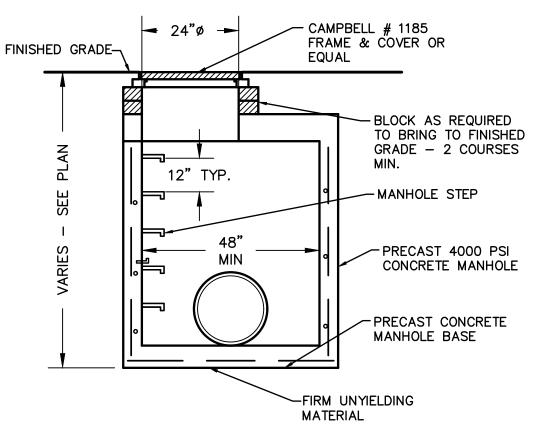N, Y, S. Lic. No. 070988

REV.

DESCRIPTION

WEINBERGLIP
ENGINEERING
PATRICIA LANE, SPRING VALLEY, NEW YORK 109

EGATION KNESSET ISRAEL
VILLAGE OF NEW HEMPSTEAD
ROCKLAND COUNTY, NEW YORK
ONSTRUCTION DETAILS


CONGREGATION
VILLAGE OF N
ROCKLAND CC

Job number: 23005 Drawn by:

Orawn by: CE Date:

12/05/24 Scale: N.T.S.

Drawing Number:

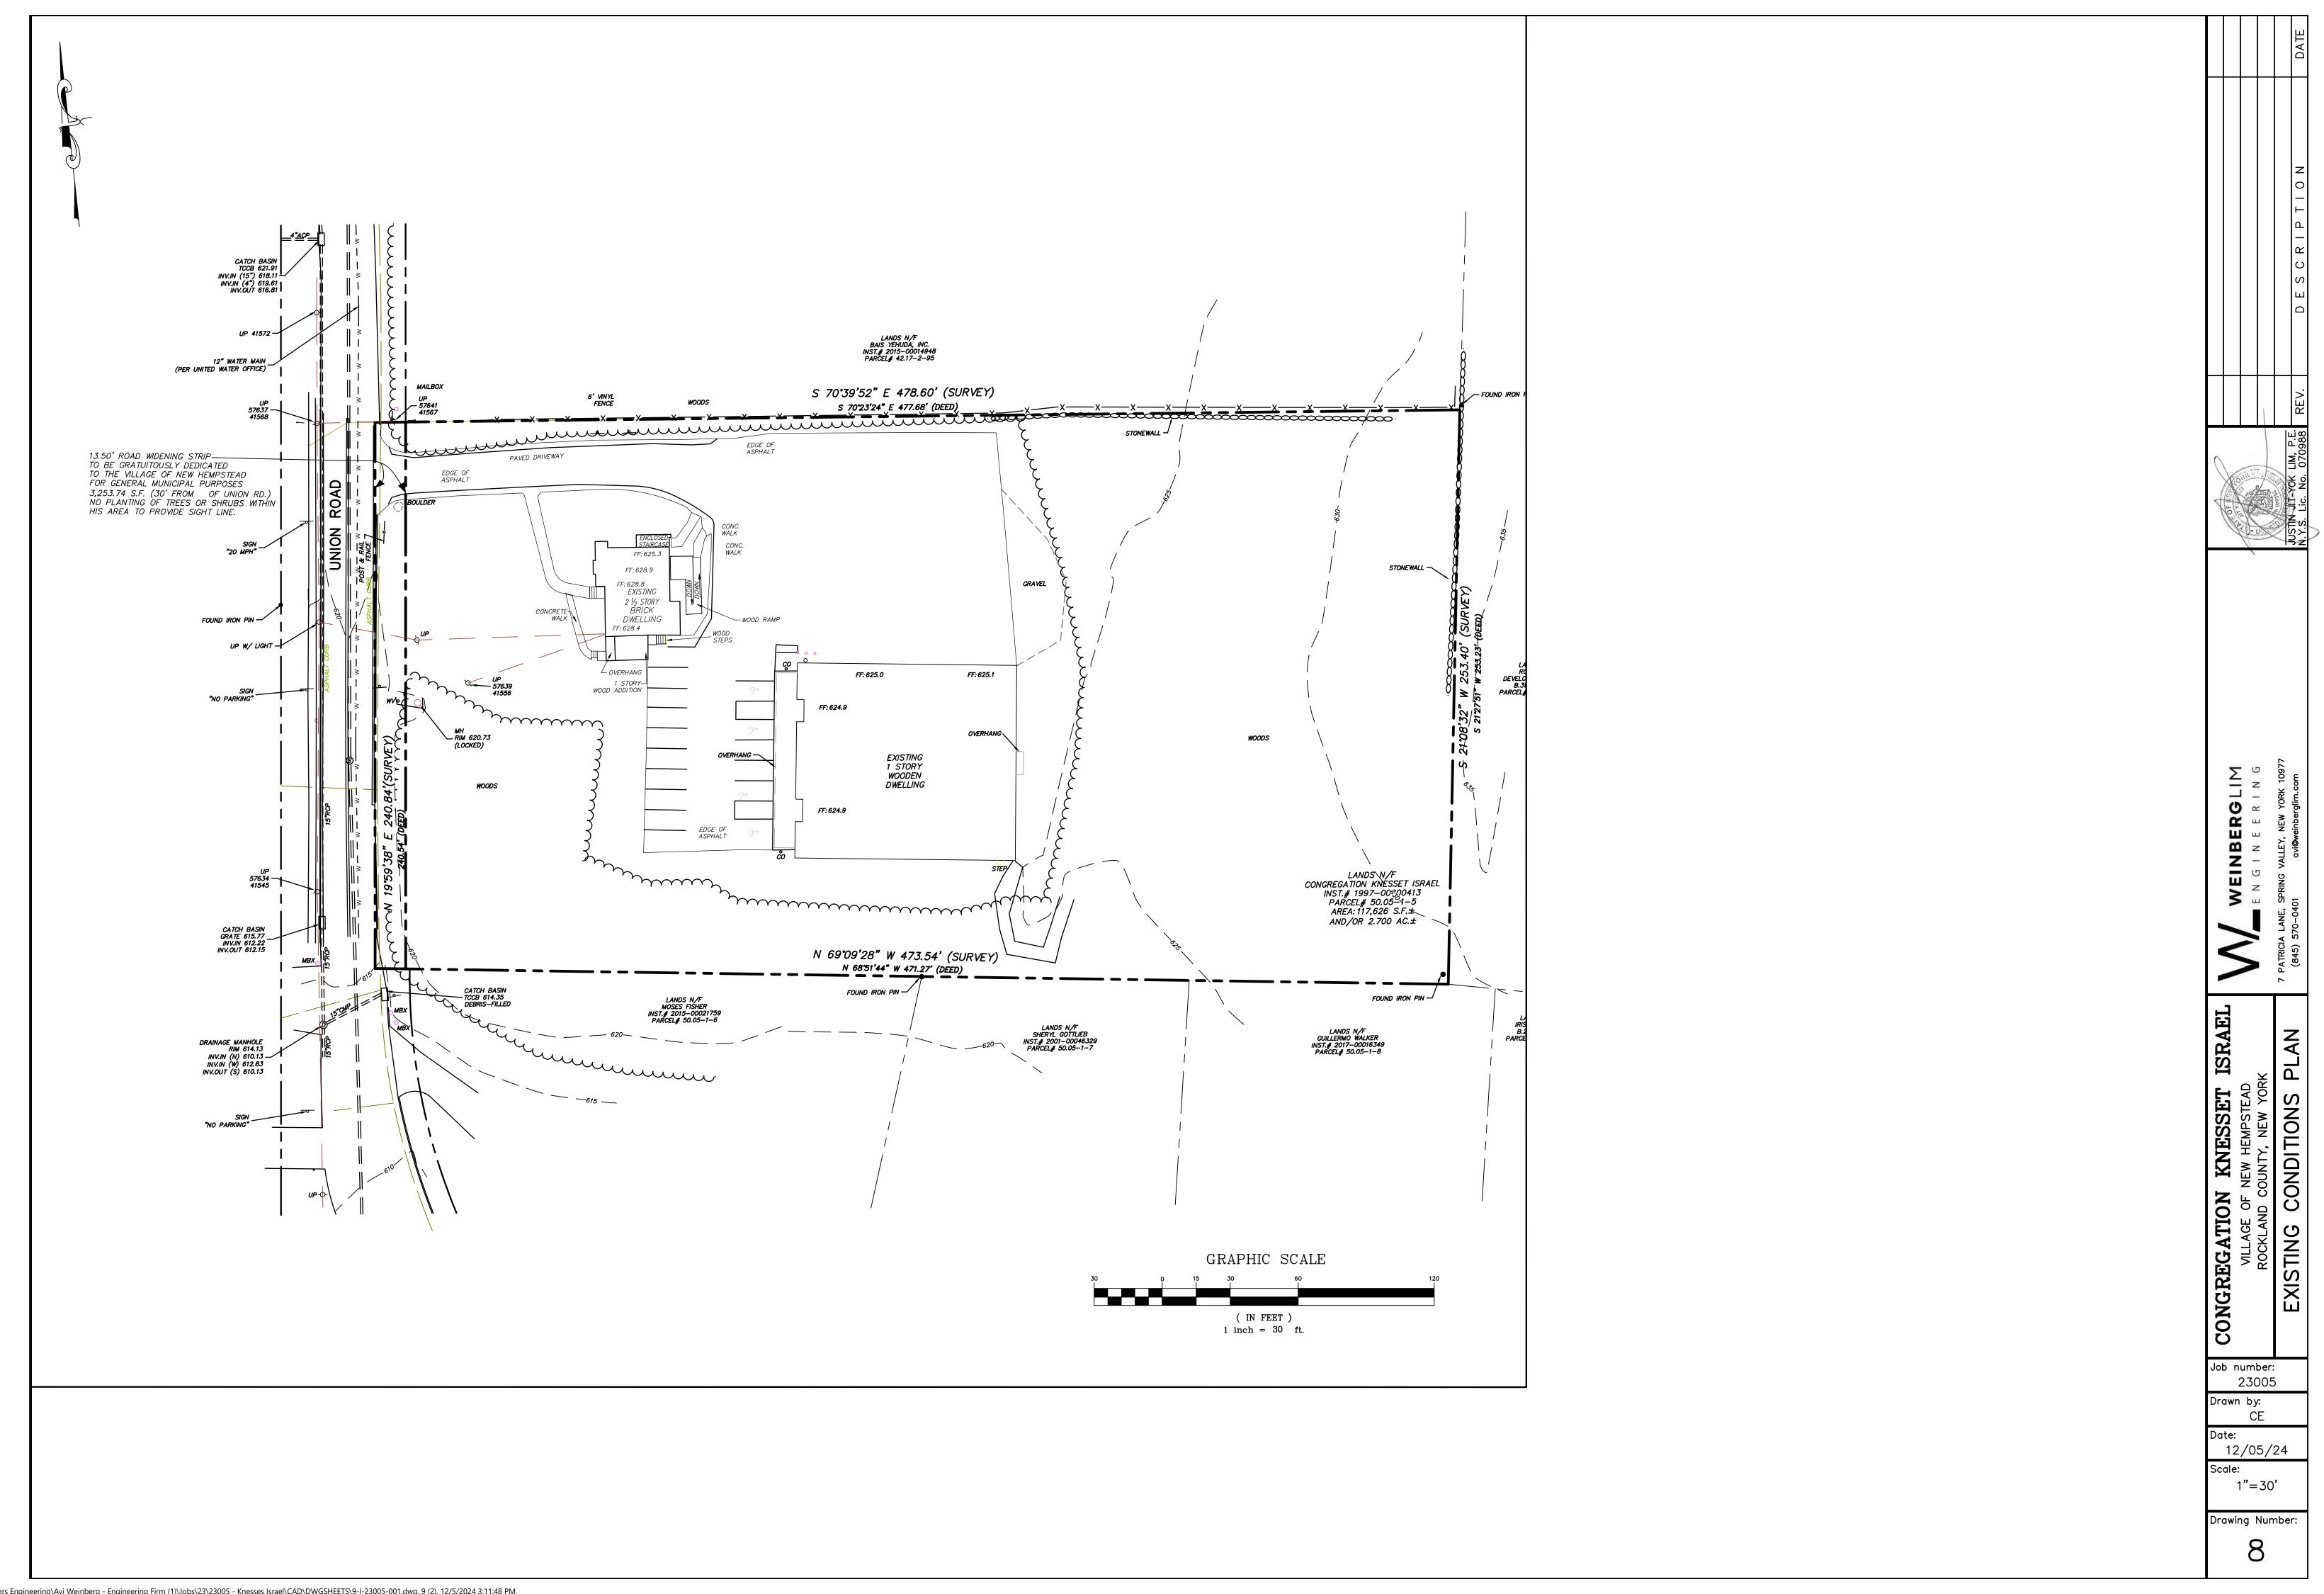

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